

### NATIONAL SENIOR CERTIFICATE

**GRADE 12** 

#### **ENGINEERING GRAPHICS AND DESIGN P1**

**NOVEMBER 2013** 

**MARKS: 100** 

TIME: 3 hours

This question paper consists of 6 pages.



#### **INSTRUCTIONS AND INFORMATION**

- 1. This question paper consists of FOUR questions.
- 2. Answer ALL the questions.
- 3. ALL drawings are in first-angle orthographic projection, unless otherwise stated.
- 4. ALL drawings must be completed using instruments, unless otherwise stated.
- 5. ALL answers must be drawn accurately and neatly.
- 6. ALL the questions must be answered on the QUESTION PAPER as instructed.
- 7. ALL the pages must be re-stapled in numerical sequence, irrespective of whether the question was attempted.
- 8. Time management is essential in order to complete all the questions.
- 9. Print your examination number in the block provided on every page.
- 10. Any details or dimensions not given must be assumed in good proportion.


FOR OFFICIAL USE ONLY											
QUESTION	MARKS OBTAINED		1/2	SIGN	MC	DERAT	ED	1/2	SIGN		
1											
2											
3											
4											
TOTAL											
	2	0	0			2	0	0			

FINAL CONVERTED MARK	CHECKED BY
100	
100	

COMPLETE THE F	OLLOWING:
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CENTRE NUI	
EXAMINATION I	NUMBER
EXAMINATION I	NUMBER

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Engineering Graphics and Design/P1 NSC DBE/November 2013

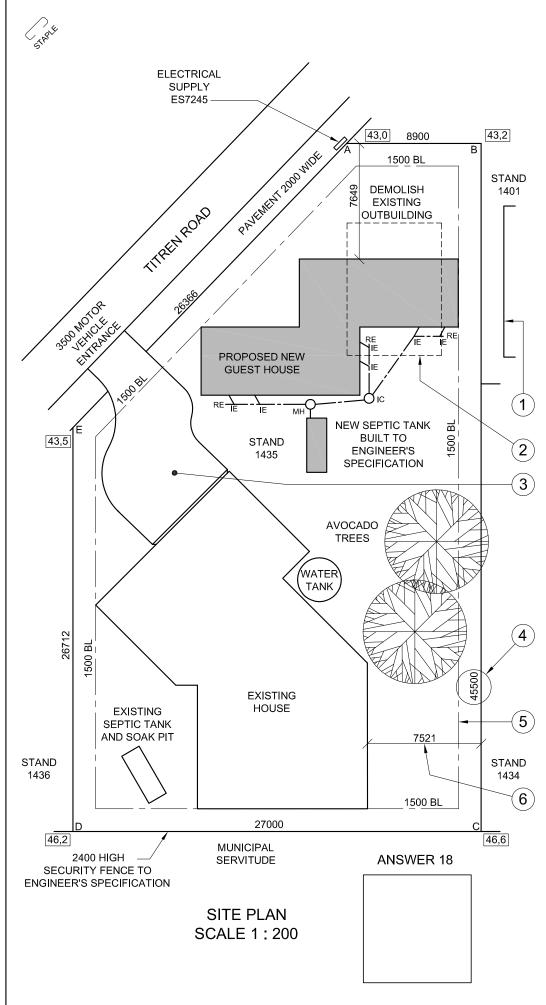

#### NOTE

Contractors must verify all dimensions and levels on site before commencing work. Architects to be notified immediately of any discrepancies.

19. In the space below, draw, in neat freehand, the front view and top view of the SANS 10143 graphical symbol (convention) for a SINGLE KITCHEN SINK.

## ARCHITECT'S SIGNATURE .......

SEPTIC TANK

DRIVEWAY

DESCRIPTION

PROJECT

2

REVISION

PROPOSED NEW GUEST HOUSE FOR MR R VAN DER LINDE ON STAND 1435 AT 5 TITREN ROAD SEA VIEW.

2013-06-12

2013-05-25

DATE

PRINTED BY
SPEEDPRINT
DRAWING TITLE

DATE OF PRINT
2013-07-01

#### SITE PLAN

PROJECT NUMBER	DRAWING NUMBER				
114	003				
REFERENCE CODE	DRAWN BY	DATE			
Q1P1-NOV-2013	JASON	2013-03-14			
SCALE	CHECKED BY	DATE			
1:200	MINKI	2013-03-18			

CM ARCHITECTS

21ST FLOOR THE SQUARE 320 SMITH STREET DURBAN Tel: 031 352 6788/9

#### QUESTION 1: ANALYTICAL (CIVIL)

#### Given:

The site plan for a proposed new guest house, a title panel and a table of questions. The drawing has not been prepared to the indicated scale.

#### Instructions:

Complete the table below by neatly answering the questions, which all refer to the accompanying drawing and title panel. [30]

			Įo,	٧,
	QUESTIONS	ANSWERS		
1	How many revisions have been made to the drawing?		1	
2	How many signatures are required on the site plan?		1	
3	What is the project number?		1	
4	How wide is the motor vehicle entrance in metres?		1	
5	What does the abbreviation MH stand for?		1	
6	6 How high is the security fence in metres?			
7	What does the feature at 1 indicate?		1	
8	What does the line at 2 indicate?		1	
9	Name the feature at 3.		1	
10	What does the number at 4 indicate?		1	
11	What does the line at 5 indicate?		1	
12	If scale 1:50 was used for the site plan, what would the dimension at 6 read?		1	
13	13 What is the reference number of the electrical supply?			
14	What type of tree is found on the stand?		1	
15	In what SI unit are the dimensions?		1	
16	16 Is corner C of stand 1435 higher or lower than Titren Road?			
17	What is the shortest distance in metres from the proposed new guest house to Titren Road?			
18	If the side of the existing house that faces Titren Road is the south-west elevation, draw, in the space provided below the site plan and in neat freehand, a correctly orientated SANS 10143 north-point symbol.		4	
19	In the space provided in the title panel, draw, in neat freehand, the front view and top view of the SANS 10143 graphical symbol (convention) for a single kitchen sink.		4	
20	In the space below, determine the perimeter of the new guest house in metres.		3	
	ANSWER 20 10500	TOTAL	30	
8	Show ALL calculations.  NEW GUEST HOUSE  10500			
	17000	EXAMINATION NUMBER		
· 		EXAMINATION NUMBER		2
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#### **QUESTION 2: INTERPENETRATION AND** DEVELOPMENT


#### Given:

- The incomplete front view and top view of a right square prism that has been shaped to fit around a right equilateral triangular prism. The axes of both prisms lie in a common vertical plane.
- The auxiliary views of the square prism.

#### Instructions:

Draw, to scale 1 : 1, the following:

- 2.1 The given top view
- 2.2 The complete front view clearly showing the curve of interpenetration
- 2.3 The development of the surface of the square prism. Make **AB** the seam.
- Show ALL hidden detail.
- Show ALL necessary construction and fold lines.

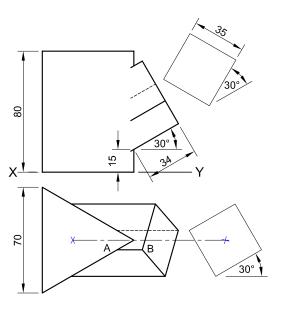

ASSESSMENT CRITERIA							
1	TOP VIEW	7½					
2	FRONT VIEW	14					
3	DEVELOPMENT	11½					
TOTAL 33							
	EXAMINATION NUMBER						

**EXAMINATION NUMBER** 

[33]



# STEP

**QUESTION 3: PERSPECTIVE** 

#### Given:

Two views of a recreational area and the information needed to draw a two-point perspective drawing.

PP - Picture plane

HL - Horizon line

GL - Ground line

SP - Station point

#### Instructions:


Complete the perspective drawing.

- Align the drawing sheet with the ground line (GL).Determine and label the vanishing points.
- Show ALL necessary construction.
- NO hidden detail is required.

[41]

HL

PP

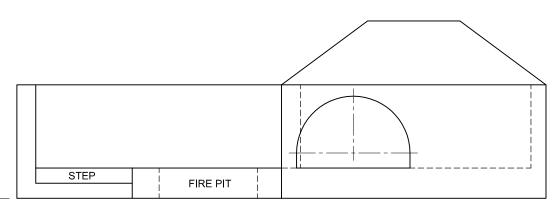


GL





ASSESSMENT CRITERIA							
1	CONSTRUCTION + VPs	7					
2	WALLS	13½					
3	BUILDING + ROOF	9					
4	ARCH + CONSTR' + PIT	11½					
TOTAL 41							
	EXAMINATION NUMBER						


**EXAMINATION NUMBER** 

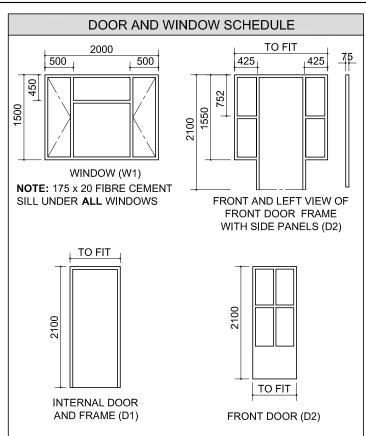



ROOF COMPONENTS					
75 x 50 PURLINS					
200 x 20 FASCIA BOARD					
114 x 38 WALL PLATE					
125 x 100 GUTTER					
ROOF CAP	300				

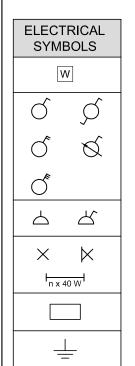

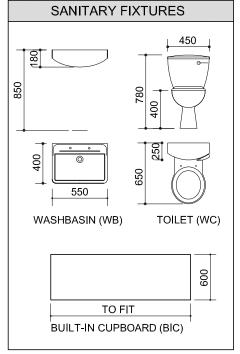


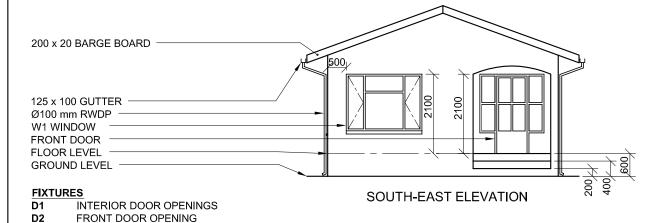

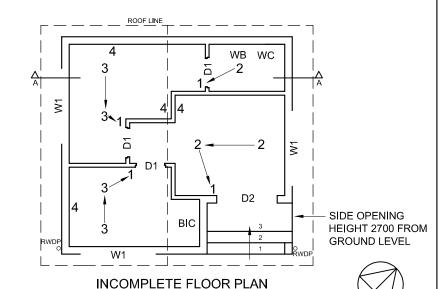

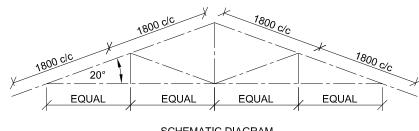

SCHEMATIC DIAGRAM OF A ROOF TRUSS

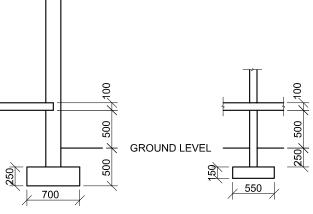

INCOMPLETE FOUNDATION AND EXTERNAL WALL DETAIL

WINDOW OPENINGS

**TOILET** 

ELECTRICAL FITTINGS

1. SINGLE-POLE LIGHT SWITCH

2. CEILING LIGHT

**ROOF NOTES:** 

SPACED

WASHBASIN BUILT-IN CUPBOARD

3. 2 x 40 W FLUORESCENT TUBES

THE ARROW SHOWS THE LIGHT

114 x 38 mm ROOF TRUSSES ON 114 x 38 mm WALL PLATES

ROOF PITCH 20° WITH 200 x 20 mm FASCIA BOARD ON BOTH ENDS

125 x 100 mm GUTTER ON BOTH ENDS

PLASTER CEILING BOARD ON 6 STRIPS OF 38 x 38 mm BRANDERING, EVENLY

ROOF COVER 15 mm CORRUGATED

IRON ON 75 x 50 mm PURLINS @ 1800 c/c

CONNECTION TO THE SWITCH.

4. SWITCH SOCKET OUTLET


W1

WC

WB

BIC

NOTE

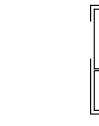

INCOMPLETE FOUNDATION
AND INTERNAL WALL DETAIL



FLOOR FINISH

RECEPTION: WOOD

CARPET

CARPET

TOILET

RECEPTION

WOOD

ROOM 1:

ROOM 2:

ROOM 2

TOILET:

#### **QUESTION 4: CIVIL DRAWING**

#### Given:

- The complete south-east elevation of new consulting rooms, showing the walls, the window, the front door, the roof and notes
- The incomplete floor plan, showing the walls, position of the windows, doors, fixtures and the electrical fittings
- Roof notes and a schematic diagram of a roof truss
- Incomplete foundation and wall detail
- The floor finishes and a diagram showing the room designations
- A door and window schedule
- A table of roof components
- A table of electrical symbols
- A table of sanitary fixtures
- The incomplete floor plan of the new **consulting rooms**, drawn to scale 1:50, on page 6

#### Instructions:

- Answer this question on page 6.
- Using the given incomplete floor plan, draw, in first-angle orthographic projection and to scale 1 : 50, the following views of the new **consulting rooms**:
- 4.1 The complete floor plan
- 4.2 A sectional elevation on cutting plane A-A
- 4.3 The north-east elevation
- ALL drawings must comply with the guidelines and graphical symbols contained in the SANS 10143.

#### SPECIFICATIONS:

THE FLOOR PLAN

#### Add the following features to the drawing:

- ALL doors and windows
- ALL the sanitary fixtures as indicated by the abbreviations
- ALL the electrical fittings as indicated by the numbers
- ALL hatching detail

#### THE SECTIONAL ELEVATION

#### Show the following features on the drawing:

- The complete foundation, wall, slab, roof and ceiling detail
- The window detail, with a double lintel, and the door detail
- The sanitary fixtures
- ALL hatching detail

#### THE NORTH-EAST ELEVATION

#### Show the following features on the drawing:

- The outside walls and finished floor level
- The roof detail, including the gutter, fascia board and rain-water downpipe
- The window detail


#### Label the following:

- The room designations with floor finishes
- The sectional elevation and north-east elevation
- Using the correct abbreviations, label the following features in the correct view: ground level and damp-proof course.

#### NOTE

• ALL substructure hatching may be drawn in freehand. [96]



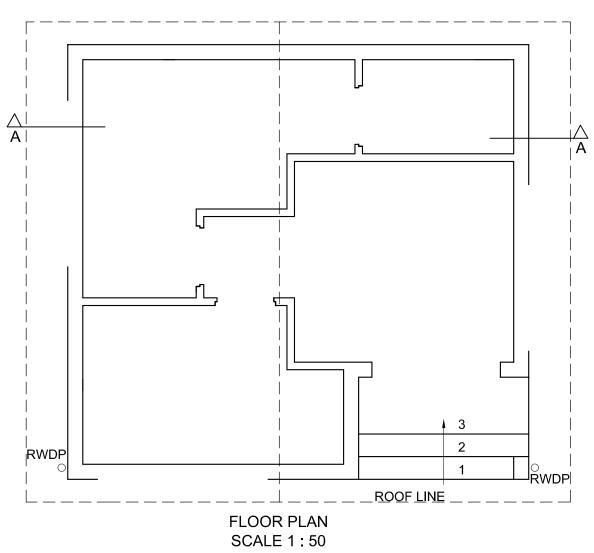

	ASS	ESSMEN	IT CRITE	RIA	
		FLOOR	PLAN		
		POSSIBLE	OBTAINED	SIGN	MODERATED
1	LABELS	4			
2	ELECTRICAL	11			
3	FITTINGS	6			
4	DOORS + WINDOWS	14			
5	HATCHING	3			
	SUBTOTAL	38			
	SEC	TIONAL	ELEVATI	ON	
1	ROOF	16			
2	WALLS + FLOOR + FOUNDATIONS	11			
3	WINDOW	2			
4	LABELS	3			
5	HATCHING	6			
6	FIXTURES	4			
	SUBTOTAL	42			
	NOR'	TH-EAST	ELEVAT	ION	•
1	WALLS + FFL	5			
2	ROOF + GUTTER + RWDP	5			
3	WINDOW	5			
4	LABELS	1			
	SUBTOTAL	16			
	TOTAL	96			

EXAMINATION NUMBER